



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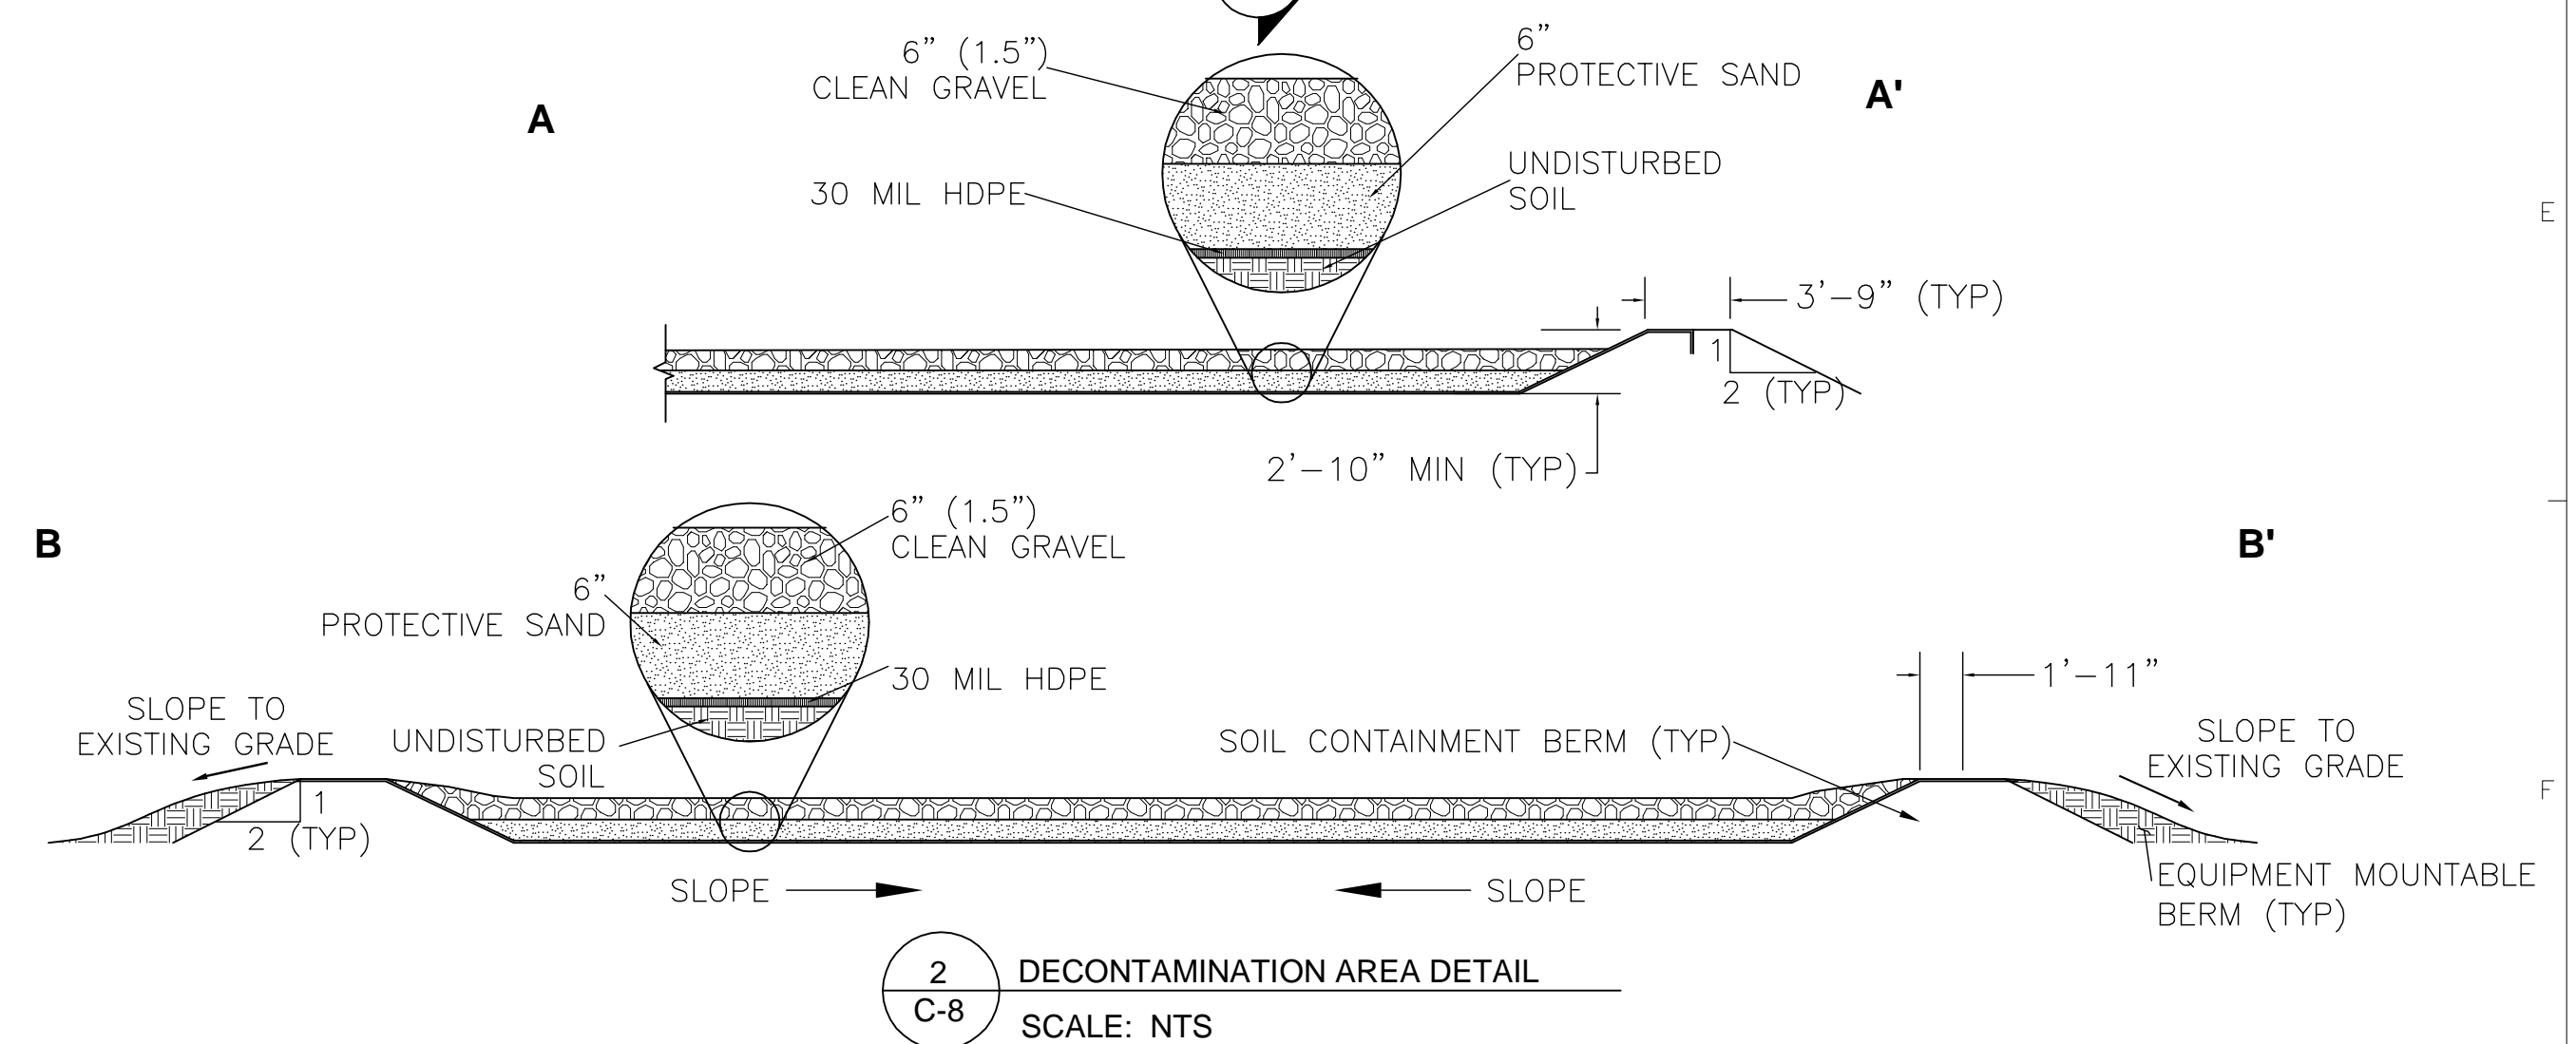
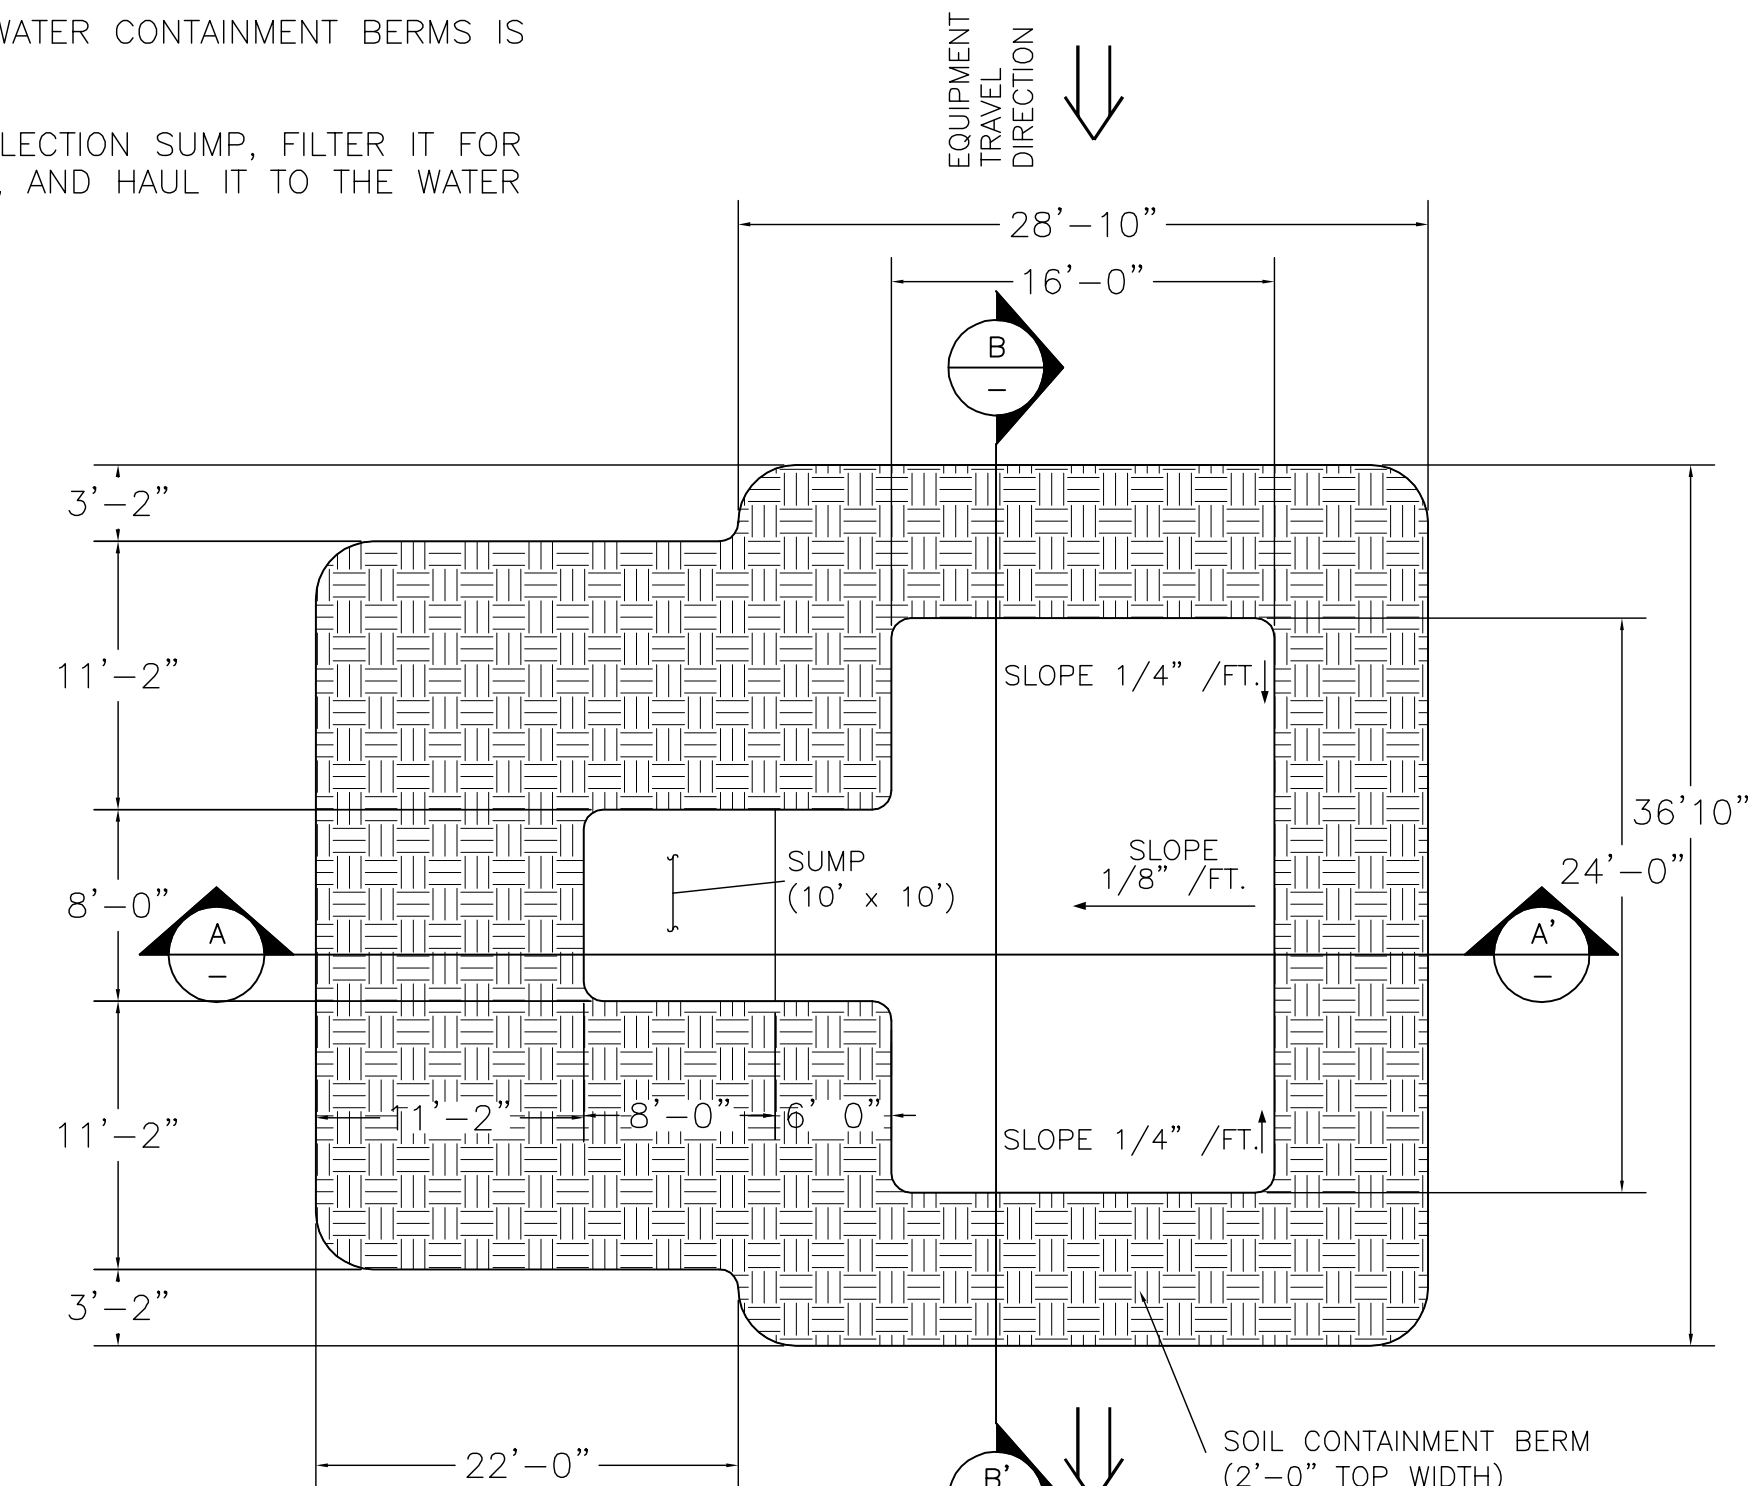
NOTES:

1. STOCKPILE AREA DIMENSIONS AND SHAPE MAY VARY. ACTUAL SIZE WILL BE DETERMINED BASED ON SITE CONDITIONS AND REQUIRED STORAGE AREA. CONTRACTOR SHALL DETERMINE FINAL SIZE OF AREA WITH APPROVAL BY SITE ENGINEER.
2. EXISTING SUBGRADE SHALL BE FREE OF ANGULAR PROTRUSIONS. A TWO TO SIX INCH LAYER OF CLEAN STRUCTURAL BACKFILL SHALL BE PLACED, GRADED TO DRAIN AND COMPACTED TO A FIRM UNYIELDING SURFACE PRIOR TO PLACEMENT OF LINER.
3. STOCKPILE AREA IS TO BE GRADED TO POSITIVELY DRAIN TOWARDS THE WATER COLLECTION AREA.
4. CONTAINMENT BERMS SHALL BE CONSTRUCTED OF IMPORTED CLEAN SOIL. NO ON SITE BORROW WILL BE AVAILABLE. PLACE WATER CONTAINMENT BERM SOILS IN MAXIMUM OF 12" LIFTS.
5. WATER CONTAINMENT BERMS ARE TO BE MOISTURE CONDITIONED AND COMPACTED TO A FIRM, UNYIELDING CONDITION, AS DIRECTED BY THE SITE ENGINEER.
6. INITIAL PLACEMENT OF EXCAVATED MATERIALS SHALL BE CAREFULLY PLACED IN A 12" LIFT SO THAT EQUIPMENT DOES NOT DAMAGE LINER.
7. DAILY INSPECTION AND MAINTENANCE OF THE WATER CONTAINMENT BERMS IS REQUIRED FOR THE DURATION OF THE PROJECT.
8. CONTRACTOR SHALL REMOVE WATER FROM COLLECTION SUMP, FILTER IT FOR DISPOSAL AT THE SITE WATER TREATMENT SYSTEM, AND HAUL IT TO THE WATER TREATMENT SYSTEM VIA TRUCK.

9. SOLIDS ACCUMULATED IN THE SUMP SHALL BE EXCAVATED PERIODICALLY AND PLACED ON THE STOCKPILE.
10. UPON COMPLETION OF THE WORK, THE WASTE MANAGEMENT AREA SHALL BE REMOVED, AND THE AREA GRADED.
11. ANY DAMAGE TO WASTE MANAGEMENT AREA MUST BE REPORTED TO THE SITE ENGINEER IMMEDIATELY.
12. LINER SHALL BE 40 MIL HDPE ONE SOLID SHEET OR SHALL HAVE SEAMS WELDED PER MANUFACTURER'S RECOMMENDATIONS. NO OVERLAP WILL BE ACCEPTED.
13. ALL WELLS TO BE PROTECTED DURING INSTALLATION AND REMOVAL OF STOCKPILE AREA.

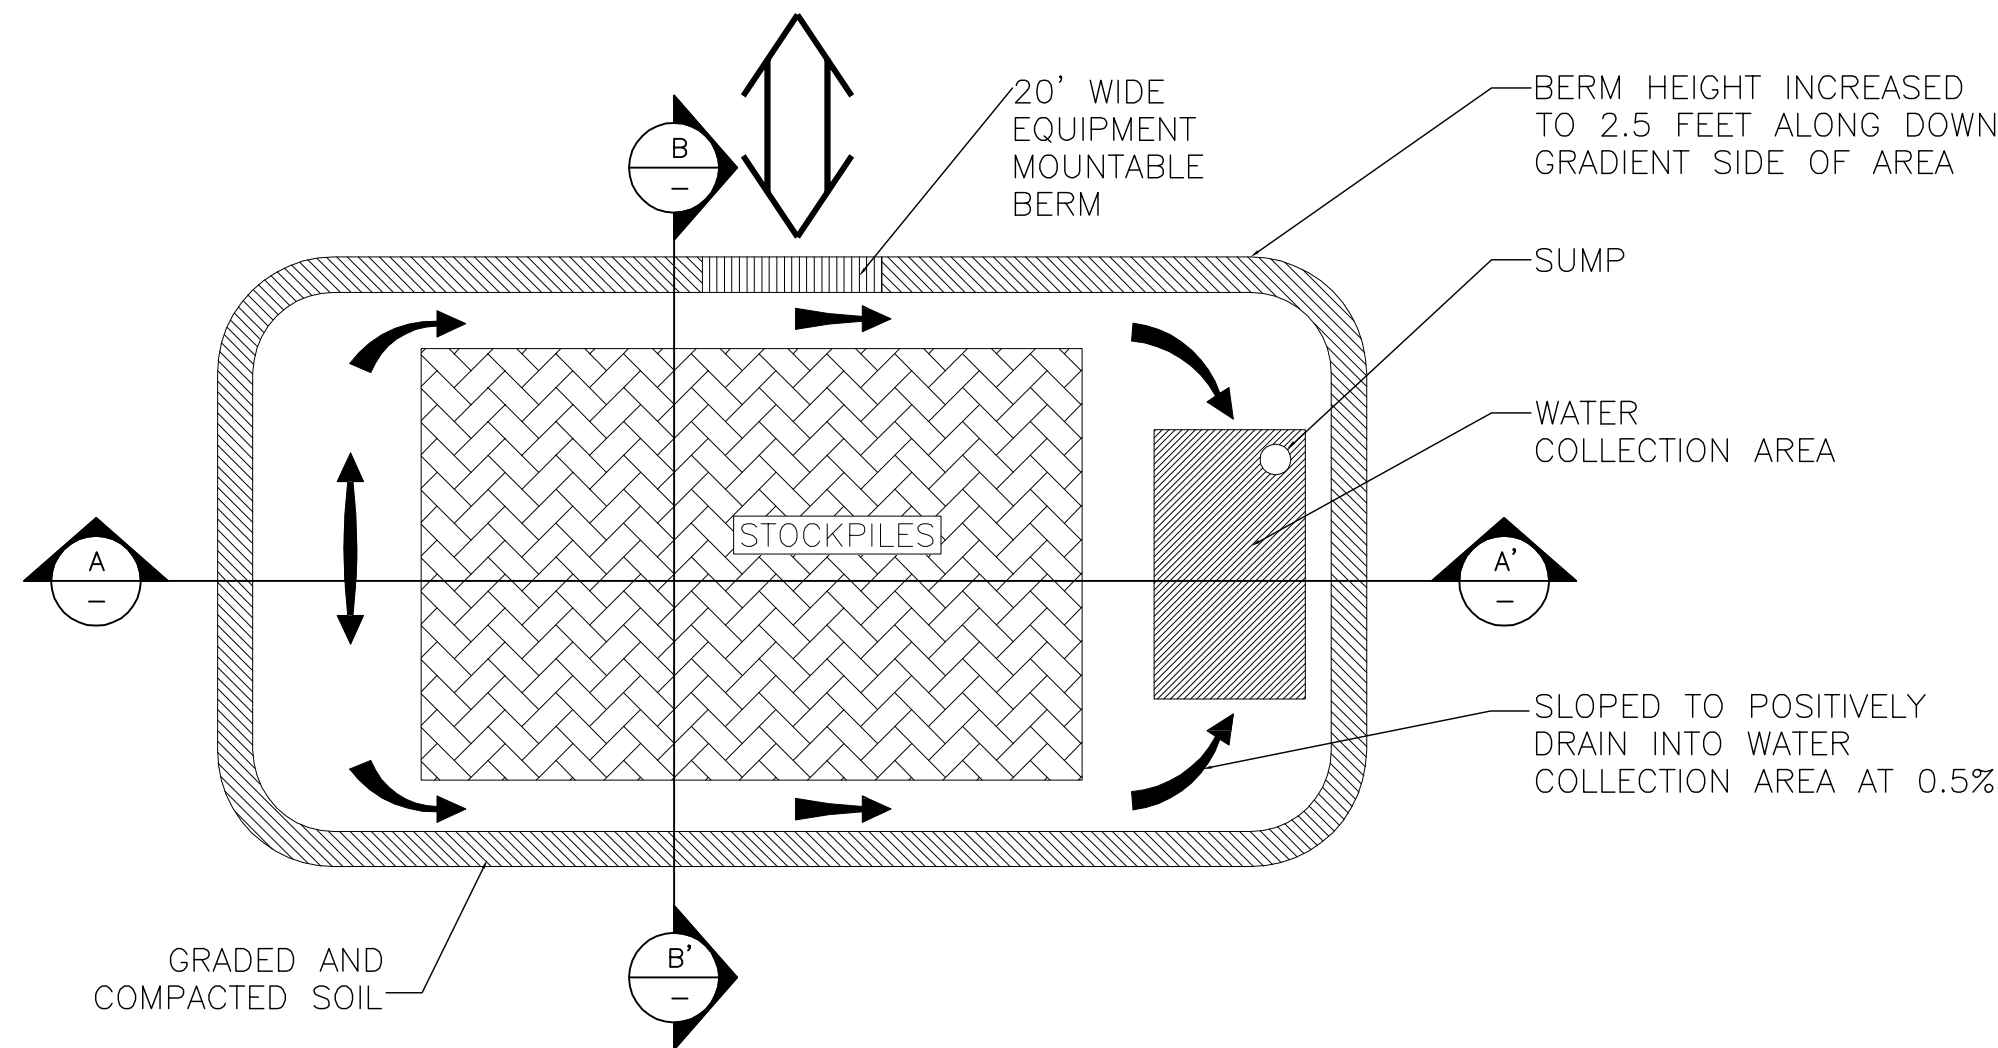

1
C-8
CONTAMINATED MATERIAL STOCKPILE AREA DETAIL
SCALE: NTS

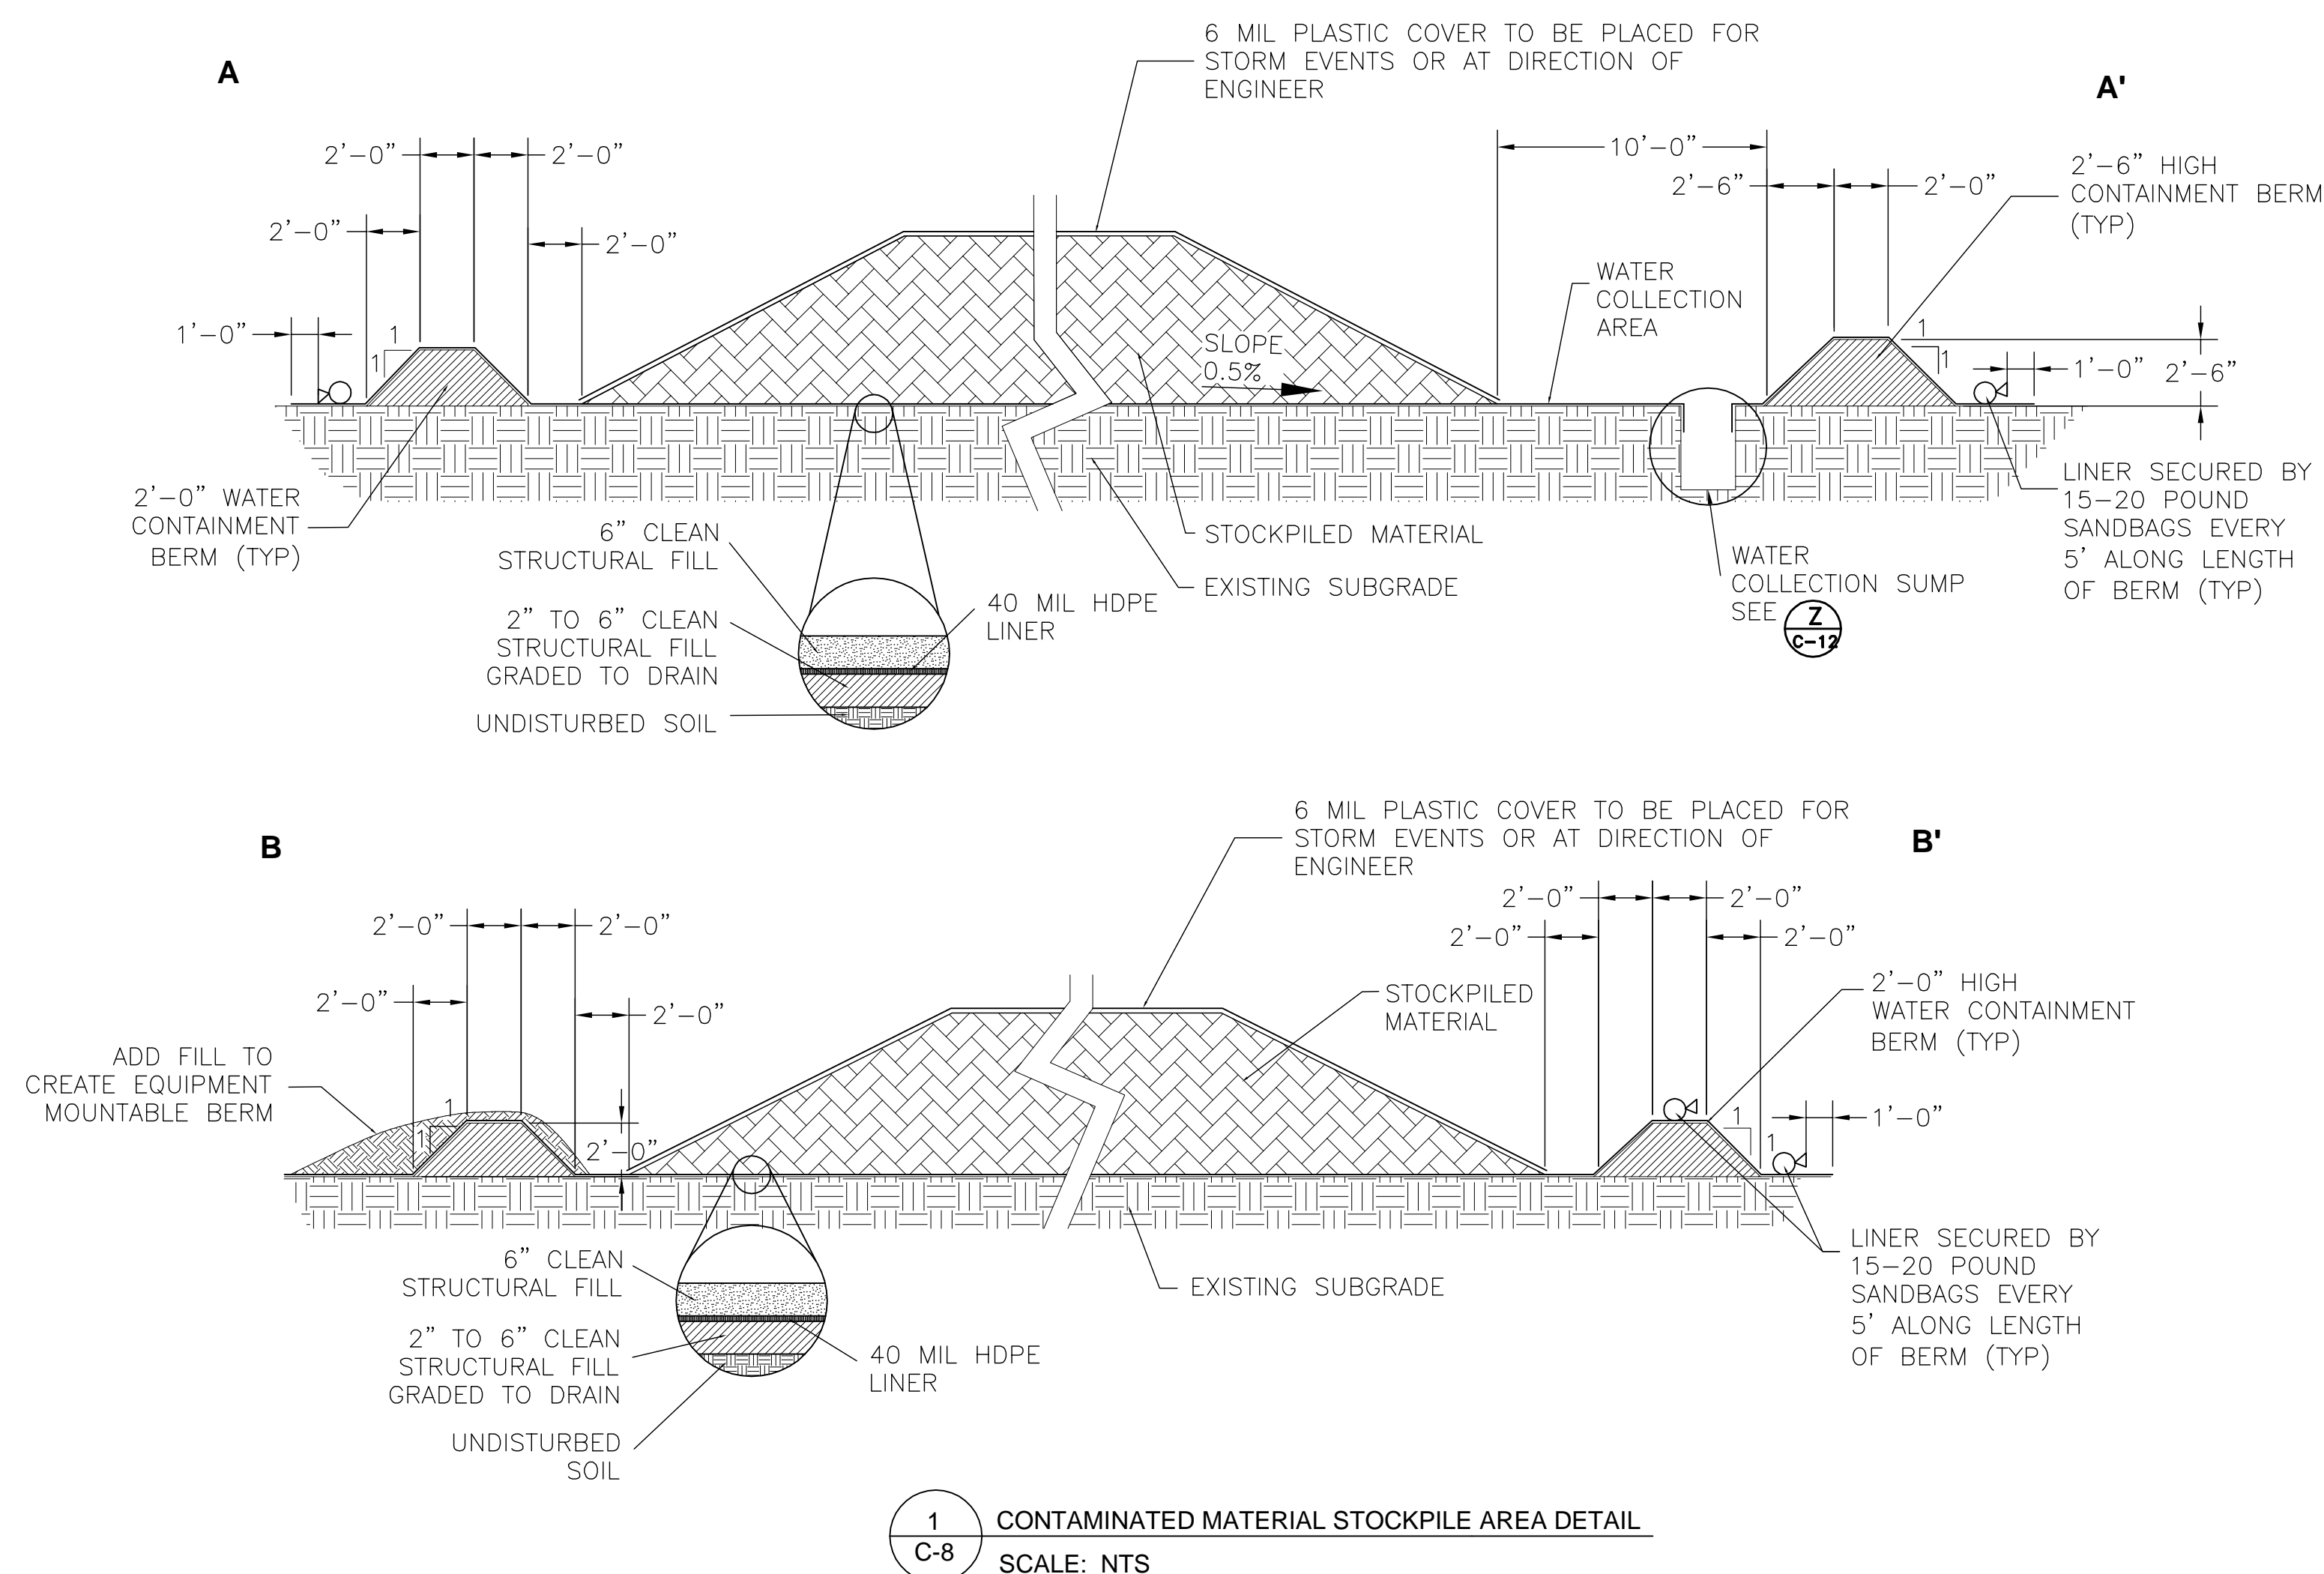

2
C-8
DECONTAMINATION AREA DETAIL
SCALE: NTS

DRAFT BID SET



B	RCW	2/--/06	ISSUED FOR PRELIMINARY BID						
A	RCW	1/17/06	60% DRAWINGS - NOT FOR CONSTRUCTION						
NO	DRWN	DATE	REVISION	CHKD	DATE	APPVD	DATE		

THE BNSF RAILWAY COMPANY
SKYKOMISH, WASHINGTON
BN050-19390-200

CURRENT DATE 2/--/06

SKYKOMISH LEVEE REMEDIATION
SEDIMENT AND EROSION CONTROL DETAILS
SHEET 1 OF 3

DRAWING NO. C-11

REVISION B